




PAVEMENT ISSUES							
	UNIT BASE B	ID ALTERNATE 1	ALTERNATE 2				
MAJOR ASPHALT CRACK	LF /////	190	550				
MINOR ASPHALT CRACK	LF /////		540				
ASPHALT INTEGRITY LOSS	SF	110	360				
CURB AND GUTTER INTEGRITY LOSS	LF //160	10	360				

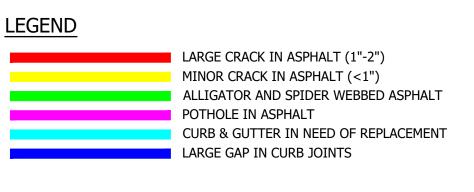

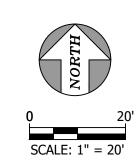

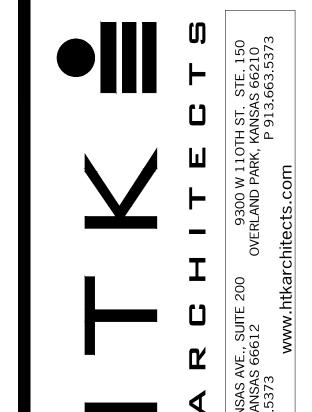





DATE: ● 4/4/2025

PUBLIC LIBRARY

KA AND SHAWNEE COUNTY ING LOT IMPROVEMENTS

SHEET CONTENTS:

• EXISTING CONDITIONS

HTK PROJECT NUMBER:

■ 2001.01-018

LIBRARY **PUBLIC**

. THE CONTRACTOR SHALL MONITOR EROSION AND SEDIMENT CONTROL MEASURES THROUGHOUT THE PROJECT. THIS PLAN MAY BE UPDATED AS CONSTRUCTION PROGRESSES WITH APPROVAL OF ENGINEER. TEMPORARY EROSION AND SEDIMENT CONTROL MEASURES INSTALLED AS PART OF THIS PLAN SHALL NOT BE

ESTABLISHED GRASS OR AS DIRECTED BY THE ENGINEER. IMMEDIATELY AFTER MOBILIZATION AND PRIOR TO STARTING ANY SOIL DISTURBING ACTIVITIES, THE CONTRACTOR SHALL INSTALL ANY PERIMETER EROSION AND SEDIMENT CONTROL MEASURES, GRAVEL CONSTRUCTION ENTRANCE(S) AND ANY TEMPORARY SEDIMENT BASIN(S). IT IS RECOGNIZED THAT SOME SITE

CLEARING AND PREPARATION MAY BY REQUIRED TO PROPERLY INSTALL SUCH MEASURES.

REMOVED FOLLOWING CONSTRUCTION UNTIL SLOPES ARE STABILIZED TO A NON-EROSIVE STATE WITH

THE CONTRACTOR SHALL PROVIDE ALL MATERIALS, TOOLS, EQUIPMENT AND LABOR AS NECESSARY TO INSTALL

CHAPTER OF THE AMERICAN PUBLIC WORKS ASSOCIATION STANDARD SPECIFICATIONS, SECTION 2150.

The CONTRACTOR SHALL BE RESPONSIBLE FOR MAINTAINING EROSION CONTROL DEVICES AND REMOVING

THE CONTRACTOR SHALL KEEP A WRITTEN LOG OF WHEN CONSTRUCTION ACTIVITIES BEGIN, EROSION AND SEDIMENT CONTROLS ARE INSTALLED, INSPECTED AND REPAIRED. COPIES OF LOG SHALL BE FURNISHED TO THE

THE LAND DISTURBANCE ACTIVITY HAS CEASED FOR A PERIOD OF FOURTEEN (14) CALENDAR DAYS.

DURATION OF THE PROJECT, WHICHEVER IS THE LATER DATE.

AND MAINTAIN ADEQUATE EROSION CONTROL, KEEP THE STREETS CLEAN OF MUD AND DEBRIS, AND PREVENT SOIL FROM LEAVING THE PROJECT SITE. THE CONTRACTOR'S EROSION CONTROL MEASURES SHALL CONFORM TO THE PROJECTS STORMWATER POLLUTION PREVENTION PLAN, A COPY OF WHICH SHALL BE MAINTAINED AND UPDATED

GOOD HOUSEKEEPING, INCLUDING SPILL RESPONSE SHALL BE PERFORMED IN ACCORDANCE WITH THE KANSAS CITY

THE CONTRACTOR SHALL TEMPORARILY SEED, MULCH, OR OTHERWISE STABILIZE ANY DISTURBED AREA WHERE

SEDIMENT UNTIL A MINIMUM OF 70% OF PERMANENT VEGETATION HAS BECOME STABILIZED AND ESTABLISHED. EROSION CONTROL DEVICES SHALL REMAIN IN PLACE UNTIL THE 70% ESTABLISHED VEGETATION IS MET, OR THE

BARRICADES FOR

PER CITY OF TOPEKA

SPECIFACATIONS

CONSTRUCTION PROJECT


DURATION OF

ON SITE AT ALL TIMES.

THE RECOMMENDED SEQUENCE OF CONSTRUCTION ACTIVITIES AND OF THE INSTALLATION AND REMOVAL OF EROSION AND SEDIMENT CONTROL MEASURES IS AS FOLLOWS: ANY PERIMETER CONTROL MEASURES (SILT FENCE) INCLUDING AREAS DRAINING TO A DRAINAGE WAY SUCH AS A STREAM, GRAVEL CONSTRUCTION ENTRANCE(S), CONSTRUCTION OF SANITARY SEWERS, STORM SEWERS, STRAW OR HAY BALE INLET PROTECTION AND BALE DITCH CHECKS, STREETS, FINAL GRADING, SEEDING, FERTILIZING AND MULCHING ON ALL SLOPES AND DISTURBED AREAS, INDIVIDUAL SITE CONTROL MEASURES, REMOVAL OF TEMPORARY PRACTICES, REMOVAL OF PERIMETER CONTROLS

- 10. PERIMETER SILT FENCE, BALE DITCH CHECKS AND CONSTRUCTION ENTRANCE(S) SHALL BE CONSTRUCTED IN ACCORDANCE WITH THESE PLANS OR THE CITY REQUIREMENTS. INSTALL SILT FENCE OR BALES WHERE REPRESENTED ON PLAN AS DITCH CHECKS AND SLOPE CONTROL, AROUND INLETS, ALONG ROADWAYS, AREAS DRAINING TO DRAINAGE WAYS SUCH AS A STREAM AND OTHER LOCATIONS AS NEEDED TO PREVENT SEDIMENT FROM LEAVING THE SITE. MEASURES WILL BE KEPT IN PLACE UNTIL GRASS IS ESTABLISHED.
- ALL EROSION CONTROL MEASURES SHALL BE INSPECTED AND MAINTAINED BY THE GENERAL CONTRACTOR NOT LESS THAN WEEKLY OR WITHIN 24 HOURS AFTER A RAINFALL EVENT OF 0.5 INCHES OR MORE. MAINTENANCE SHALL INCLUDE BUT NOT LIMITED TO SEDIMENT REMOVAL, SILT FENCE AND HAY BALE BARRIER REPAIR AND/OR REPLACEMENT.
- CONSTRUCTION ENTRANCES SHALL BE MAINTAINED BY THE GENERAL CONTRACTOR IN A CONDITION THAT WILL PREVENT TRACKING OR FLOWING OF SEDIMENT ONTO PUBLIC RIGHT-OF-WAYS AND PAVED STREETS. THIS MAY INCLUDE PERIODIC TOP DRESSING WITH ADDITIONAL CRUSHED STONE AS CONDITIONS WARRANT. REPAIR OF ENTRANCES, CLEANING ON A DAILY BASIS OF RIGHT-OF-WAYS AND PAVED STREETS THAT HAVE BEEN SOILED BY CONSTRUCTION ACTIVITIES SHALL BE THE GENERAL CONTRACTOR'S RESPONSIBILITY.
- 13. THE CONTRACTOR SHALL NOTIFY EACH SUB-CONTRACTOR OR ENTITY (INCLUDING UTILITY CREWS AND CITY EMPLOYEES OR THEIR AGENTS) THAT WILL BE PERFORMING WORK AT THE SITE OF THE EROSION CONTROL PLAN AND WHAT ACTIONS OR PRECAUTIONS SHALL BE TAKEN TO MINIMIZE THE POTENTIAL FOR SOIL EROSION. 14. DURING ALL SOIL DISTURBING ACTIVITIES, THE GENERAL CONTRACTOR WILL TAKE APPROPRIATE STEPS USING
- ACCEPTED CONSTRUCTION METHODS TO MINIMIZE THE TIME OF EXPOSURE OF UNPROTECTED SOIL AND OTHER CONSTRUCTION MATERIALS TO RAINFALL. 15. NO GROUND SHALL BE LEFT OPEN FOR MORE THAN 7 DAYS OF NON-ACTIVITY WITHOUT BEING MULCHED AND/OR
- 16. SOIL STOCKPILED FOR MORE THAN 7 DAYS SHALL HAVE SILT FENCE OR BALES PLACED ON THE DOWNHILL SLOPES TO TRAP SEDIMENT. 17. WHENEVER SOIL, ROCK, VEGETATION OR OTHER MATERIALS ARE EXPORTED FOR PLACEMENT IN AREAS OFF OF THE
- CONSTRUCTION SITE COVERED IN THIS PLAN, THE GENERAL CONTRACTOR IS RESPONSIBLE FOR DETERMINING THAT EPA STORM WATER PERMITTING REQUIREMENTS ARE MET. PRIOR TO THE REMOVAL OF ANY MATERIALS FROM THE SITE THE GENERAL CONTRACTOR WILL FURNISH THE ENGINEER WITH WRITTEN AGREEMENT, SIGNED BY EACH LANDOWNER WHO WILL RECEIVE EXPORTED MATERIALS, STATING THAT THEY ACCEPT THE MATERIAL AND THAT RECEIVING SITE IS PROPERLY PERMITTED, WHEN REQUIRE



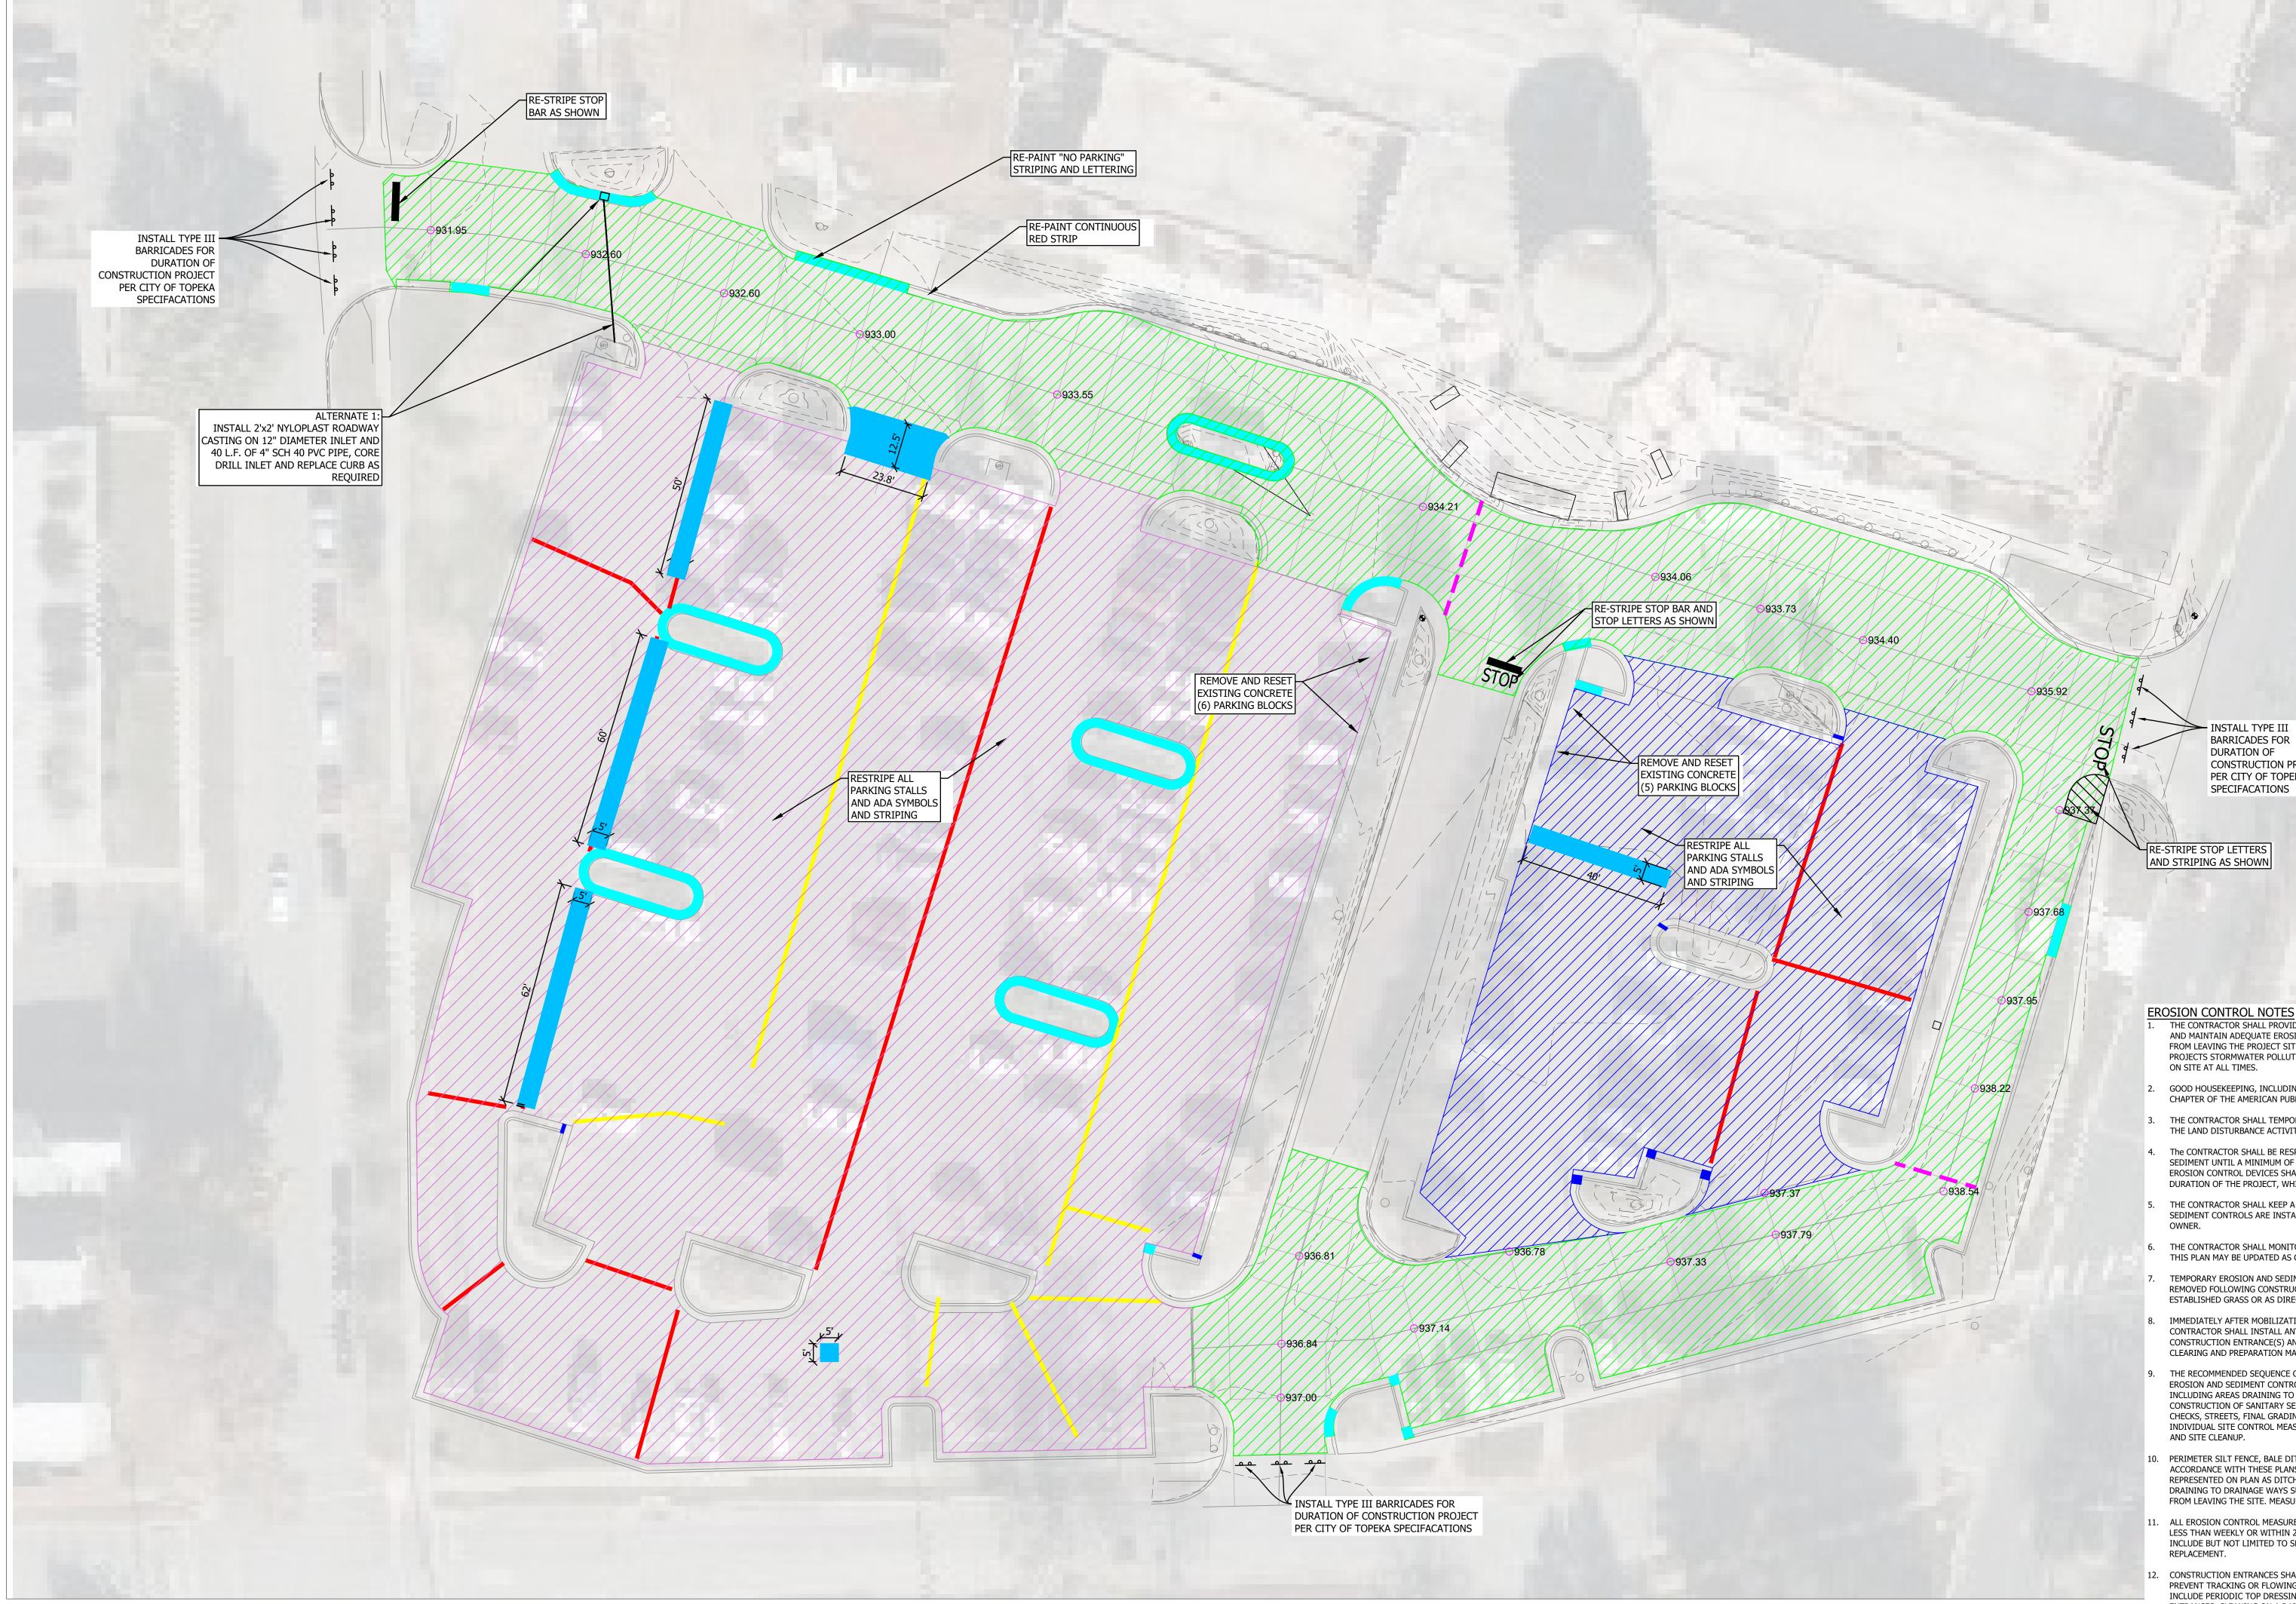


QUANTITIES							
	UNIT	BASE BID	ALTERNATE 1	ALTERNATE 2	ALTERNATE 3		
FULL DEPTH REPLACEMENT (CONCRETE)	SF	30648					
FULL DEPTH REPLACEMENT (ASPHALT)	SF			160	1647		
MILL AND 2" OVERLAY (ASPHALT)	SF			15500	57450		
CURB AND GUTTER REPLACEMENT	LF	180	4	10	360		
ASPHALT CRACK CLEAN AND FILL	LF			150	360		
SEAL CONCRETE CURB JOINT	LF			25	10		
DAMAGE CONTINGENCY - CURB AND GUTTER	LF	20		20	20		
DAMAGE CONTINGENCY - ASPHALT FULL DEPTH	SF	50					
PAVEMENT STRIPING AND ADA MARKINGS	LS	1		1	1		
ADS NYLOPLAST INLET AND CASTING	EA		1				
4" SCH 40 PVC PIPE	LF		40				

CONSTRUCTION LEGEND

CONCRETE EXPANSION JOINT

LARGE CRACK IN ASPHALT (1"-2") CONTRACTOR TO CLEAN AND FILL WITH CRACK SEALER BEFORE OVERLAY CRACK IN ASPHALT (<1") CONTRACTOR TO CLEAN PRIOR TO OVERLAY CONTRACTOR TO SAWCUT AND REPLACE ASPHALT FULL DEPTH CONTRACTOR TO REPLACE CURB & GUTTER CONTRACTOR TO FILL CONCRETE JOINT WITH JOINT SEALANT

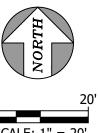

SCALE: 1'' = 20'

- PROJECT NOTES:

 1. UNLESS OTHERWISE STATED, CONTRACTOR TO MEET CITY OF TOPEKA SHAWNEE COUNTY STANDARD SPECIFICATIONS. 2. ALL CONCRETE PAVEMENT WILL BE REINFORCED WITH 6X6-W2.9XW2.9
- SAWCUTTING IS SUBSIDIARY. 4. CONTRACTOR TO PROTECT EXISTING SPRINKLER SYSTEM. 5. CONTRACTOR TO COORDINATE WITH OWNER AND CONSTRUCT REPAIRS IN PHASES THAT ALLOW THE FACILITY TO STAY IN

OPERATION,

- 6. CONTRACTOR TO PROVIDE REQUIRED TRAFFIC CONTROL. CONTRACTOR SHALL SIGN ANY DRIVE ENTRANCES TO BE CLOSED OFF FROM PUBLIC STREET ACCESS WITH TYPE III BARRICADES 7. PARKING LOT STRIPING SHALL BE WATERBOURN MARKING PAINT FURNISHED IN ACCORDANCE WITH SECTION 2215 OF THE KDOT
- STANDARD SPECIFICATIONS FOR ROAD AND BRIDGE CONSTRUCTION AND APPLIED IN ACCORDANCE WITH SECTION 4.22 OF THE CITY OF TOPEKA SHAWNEE COUNTY STANDARD SPECIFICATIONS. 8. ASPHALT FOR TACK COAT SHALL BE SS-1HP, MEETING THE REQUIREMENTS OF SECTION 1203 OF THE KDOT STANDARD
- SPECIFICATIONS FOR ROAD AND BRIDGE CONSTRUCTION. 9. ASPHALT CONCRETE PAVEMENT SHALL MEET THE REQUIREMENTS OF BM-2A, IN THE CITY OF TOPEKA SHAWNEE COUNTY STANDARD
- SPECIFICATION, W/PG 70-28. 10. TIE PERIMETER OF NEW CONCRETE PAVEMENT INTO EXISTING CONCRETE CURBS AND PAVEMENT WITH NO. 4 DOWELS X 24" @ 5' CENTERS.
- 11. SEAL CONCRETE JOINTS IN ACCORDANCE WITH SECTION 5.05 OF THE CITY OF TOPEKA SHAWNEE COUNTY STANDARD SPECIFICATIONS - HOT SEALANTS ONLY.

Phone: 785.806.2806 | www.unitedeng.com


CONSTUCTION PLAN HTK PROJECT NUMBER: 2001.01-018

OPE ARK


SHEET CONTENTS:


SHEET NUMBER:

DATE:

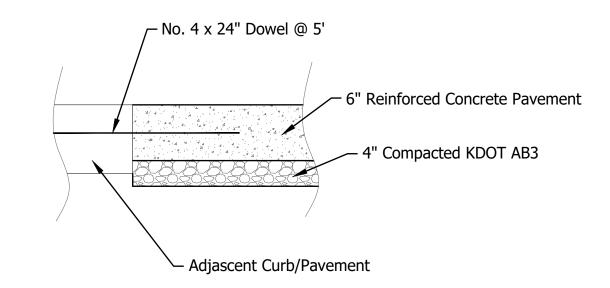




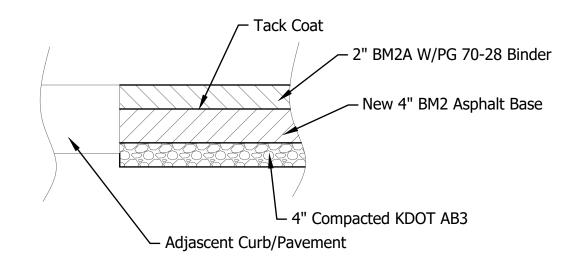

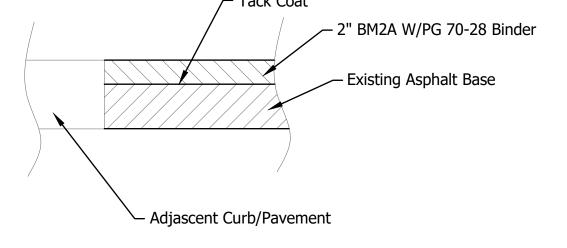

TYPICAL SECTION 2" ASPHALT



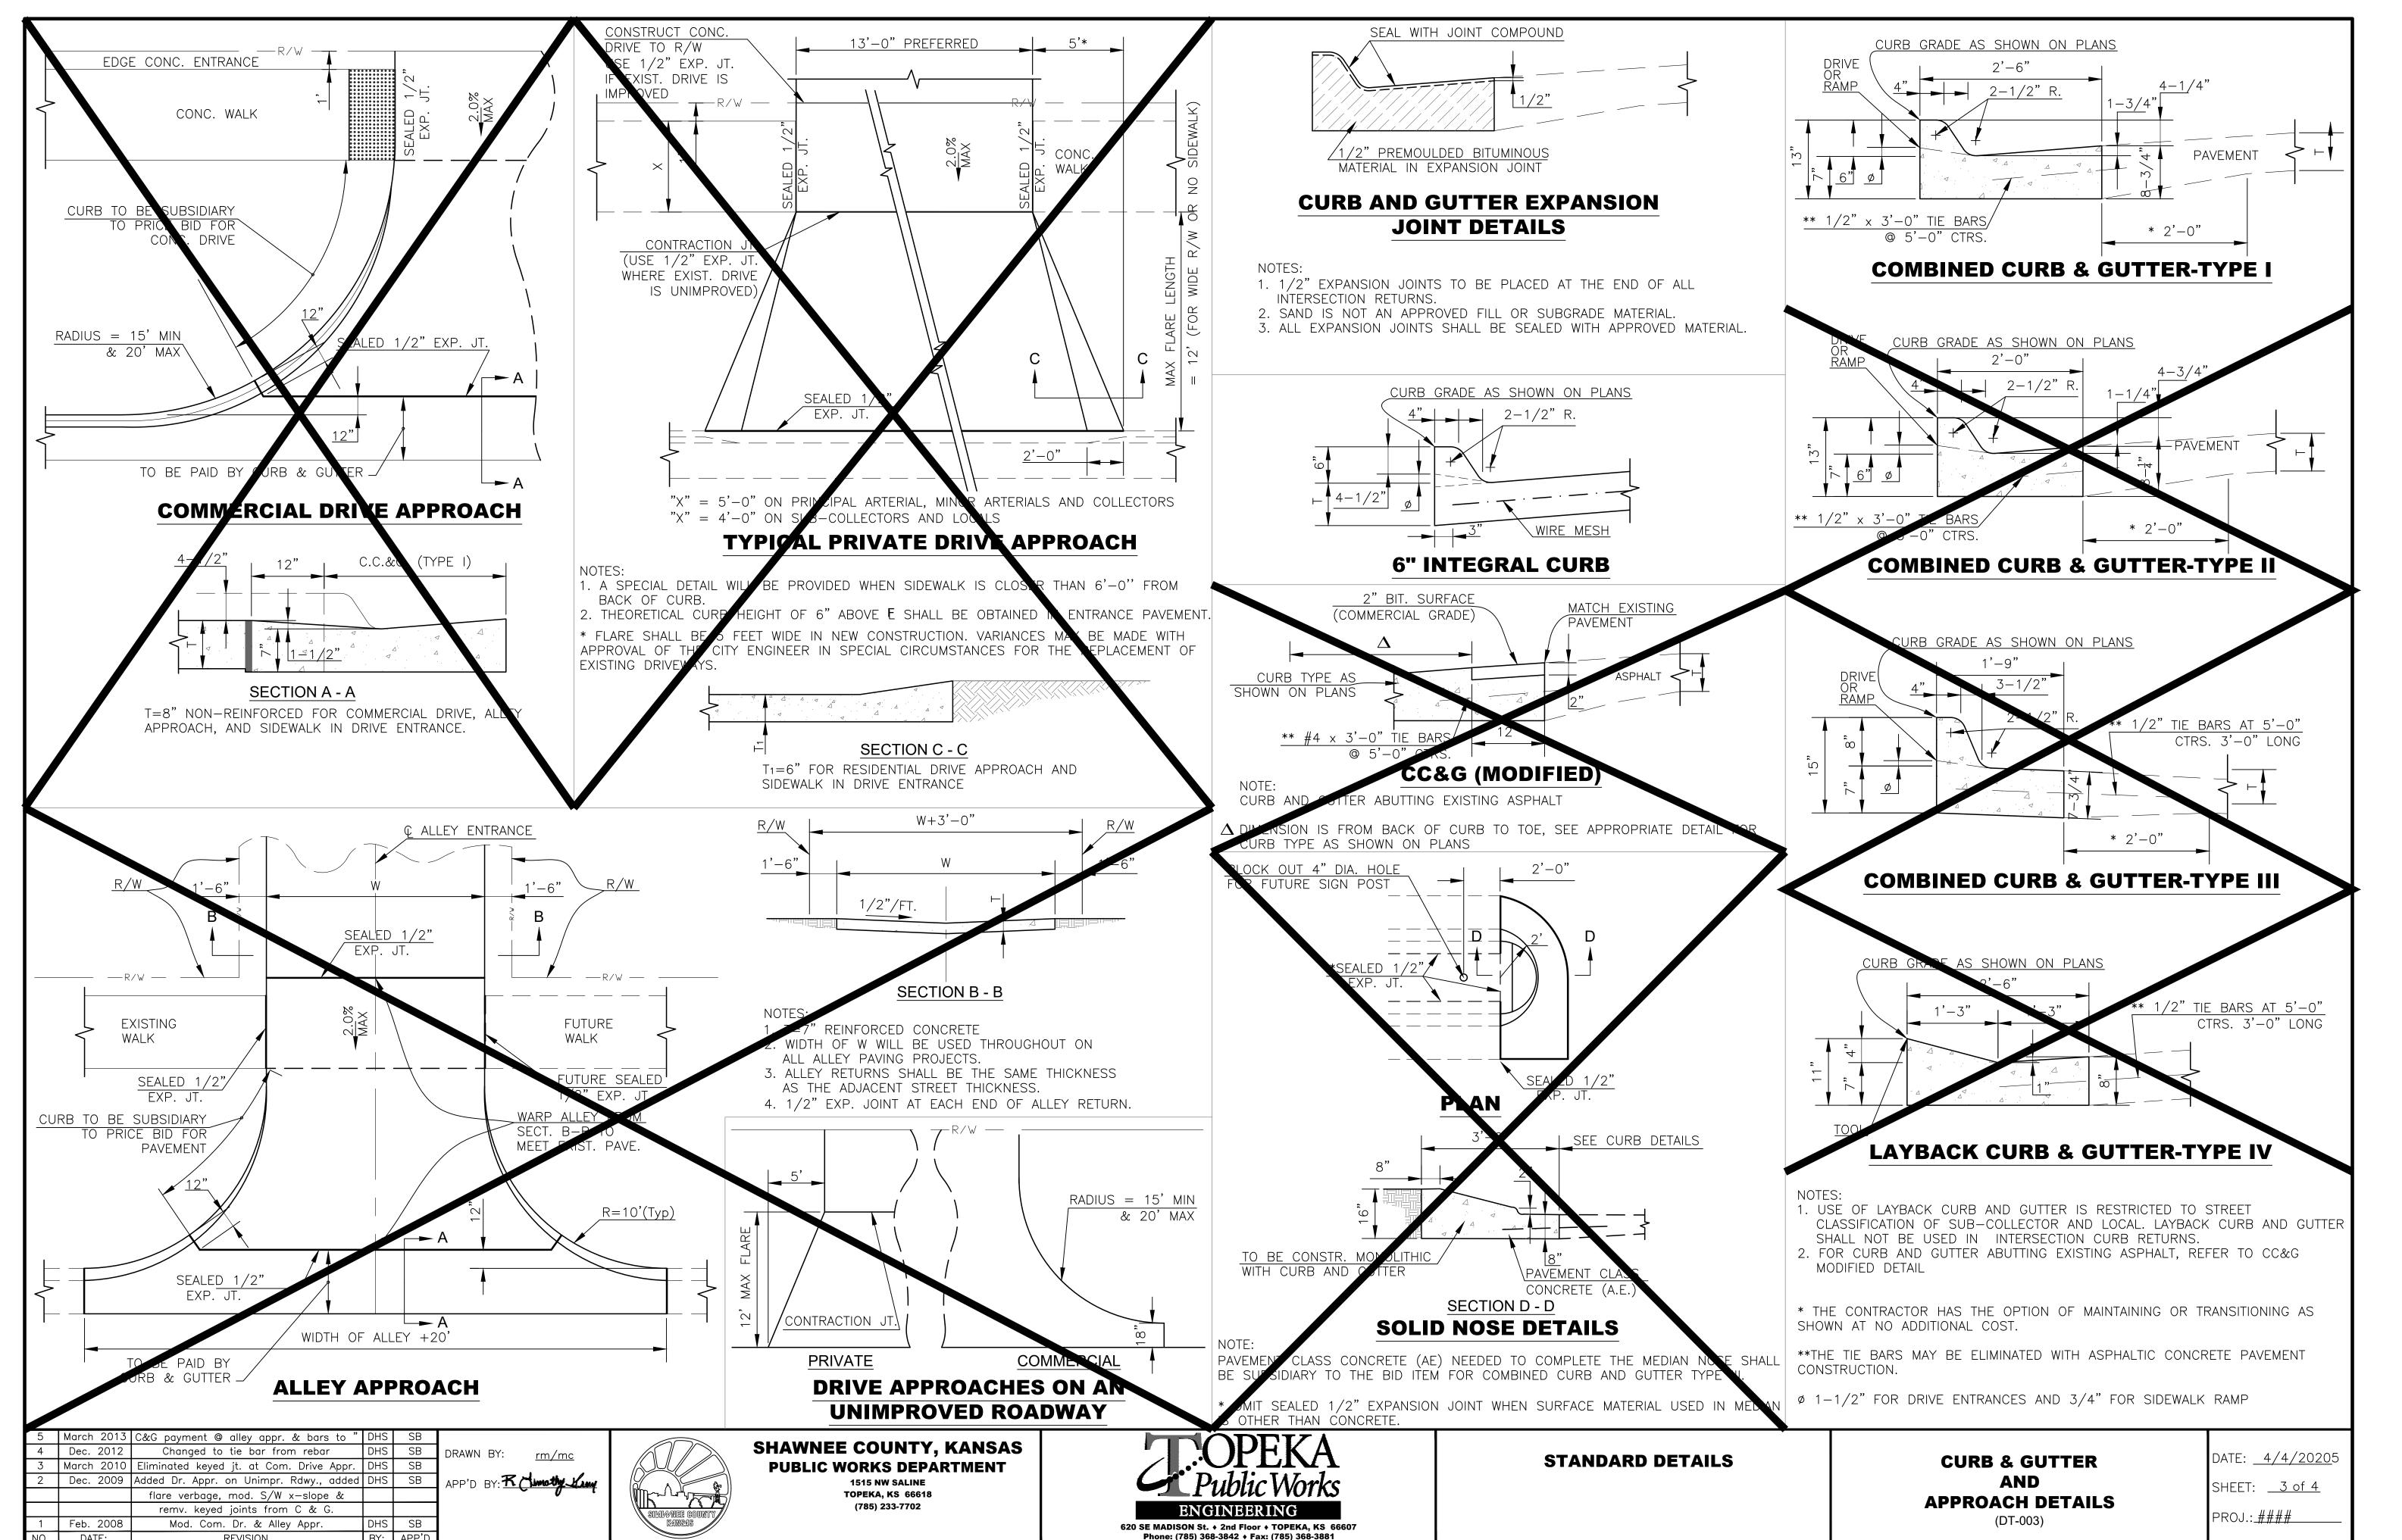



4/4/2025 REVISED DATE:

LIBRARY **PUBLIC** SHAWNEE COUNT IMPROVEMENTS AND LOT OPE ARK

engineering Phone: 785.806.2806 | www.unitedeng.com

HTK PROJECT NUMBER: 2001.01-018

CONSTUCTION PLAN

SHEET CONTENTS:


SHEET NUMBER:



SHEET CONTENTS: CONSTUCTION PLAN

HTK PROJECT NUMBER: 2001.01-018

Phone: 785.806.2806 | www.unitedeng.com

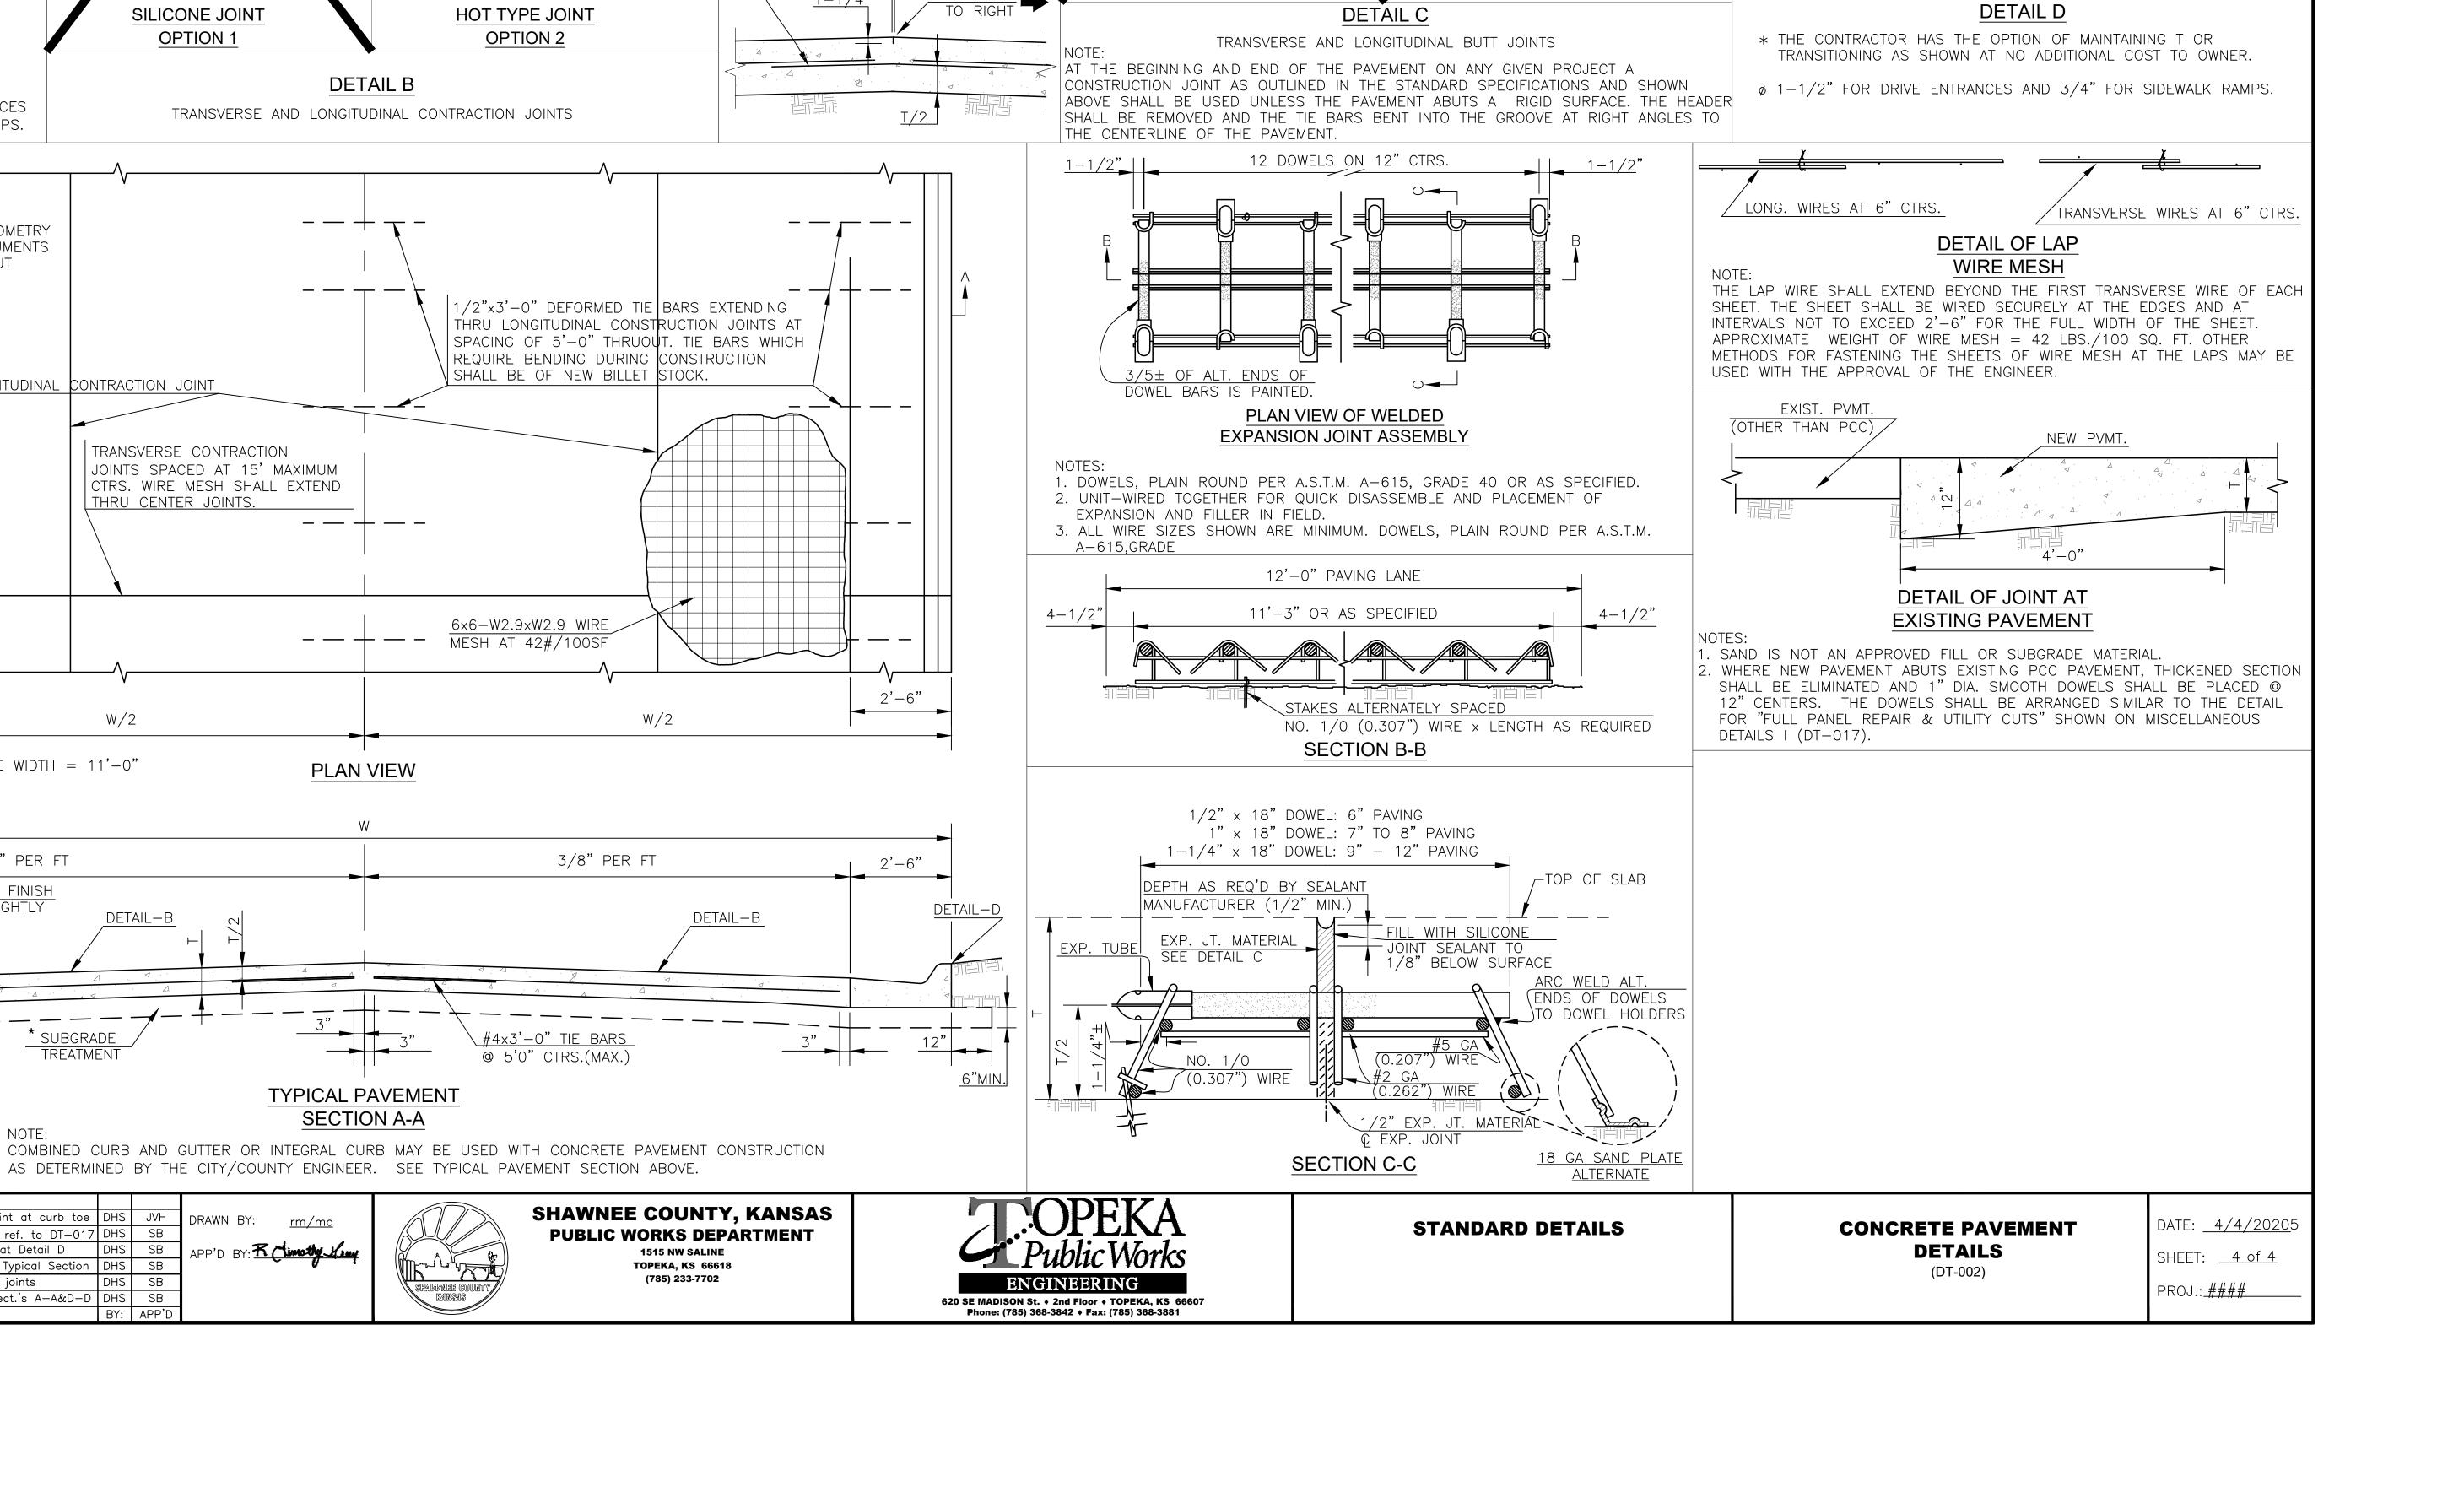

1/4" MIN.

BUTT JOINT

HOT TYPE JOINT

OPTION 2

FILL JOINT LEVEL WITH SURFACE

JOINT SEALANT

(ASTM D 3405)

TO 3/8" MAX.

SAW CUT (WET)

SILICONE JOINT

OPTION 1

1/2" x 3'-0" TIE BARS @ 5'-0" CTRS. (MAX.)

CURB GRADE AS SHOWN ON PLANS

1/2" x 3'-0" TIE BARS

@ 5'-0" CTRS.

WIRE MESH

<u>8-3/4"</u>

PUBLIC WORKS DEPARTMENT TOPEKA, KS 66618 (785) 233-7702

1/4" MIN.

HOT TYPE

1/8" INITIAL

SAW CUT (WET)

1/2"x3'-0" DEFORMED TIE BARS EXTENDING

REQUIRE BENDING DURING CONSTRUCTION

3/8" PER FT

<u>#4x3'-0" TIE BARS</u> © 5'0" CTRS.(MAX.)

SHALL BE OF NEW BILLET STOCK.

6x6-W2.9xW2.9 WIRE MESH AT 42#/100SF

JOINT SEALANT

(ASTM D 3405)

TO 3/8" MAX.

INDUCED CRACK

DETAIL B

TRANSVERSE AND LONGITUDINAL CONTRACTION JOINTS

--+-

PLAN VIEW

TYPICAL PAVEMENT

SECTION A-A

AS DETERMINED BY THE CITY/COUNTY ENGINEER. SEE TYPICAL PAVEMENT SECTION ABOVE.

APP'D BY: R Climathy King

HOT TYPE JOINT

OPTION 2

SEALANT

SILICONE JOINT

OPTION 1

TRANSVERSE CONTRACTION

THRU CENTER JOINTS.

JOINTS SPACED AT 15' MAXIMUM

CTRS. WIRE MESH SHALL EXTEND

LONGITUDINAL CONTRACTION JOINT

CURB GRADE AS SHOWN ON PLANS

DETAIL A

6" INTEGRAL CURB

REFER TO PAVEMENT GEOMETRY

SHEET IN PROJECT DOCUMENTS

NOTE: STANDARD LANE WIDTH = 11'-0"

STEEL TROWEL FINISH AND BRUSH LIGHTLY

June 2018 | Eliminated sealing butt joint at curb toe DHS | JVH

Eliminated keyed joints

Feb. 2008 Mod. Det.'s B,C&D and Sect.'s A-A&D-D DHS

Dec. 2012 Changed to tie bars at Detail D

3 March 2010 Eliminated keyed joint at Typical Section DHS

1 BOTH SIDES

* SUBGRADE TREATMENT PER

GEOTECHNICAL REPORT.

3/8" PER FT

FOR ACTUAL JOINT LAYOUT

 ϕ 1-1/2" FOR DRIVE ENTRANCES

AND 3/4" FOR SIDEWALK RAMPS.